# PENNSYLVANIA GAME COMMISSION PROJECT NO. PGC-165-23-01 STATE GAME LANDS #165


# NEW 40' x 80' CREW HEADQUARTERS BUILDING

SHAMOKIN TOWNSHIP, NORTHUMBERLAND COUNTY, PENNSYLVANIA


CONTRACT NO. 1: GENERAL CONSTRUCTION CONTRACT NO. 3: PLUMBING CONSTRUCTION CONTRACT NO. 4: ELECTRICAL CONSTRUCTION

#### SITE PLAN GENERAL NOTES:


- I. UTILITY LINE LOCATIONS SHOWN ON THE DRAWINGS ARE APPROXIMATE. UNDERGROUND TELEPHONE, ELECTRIC, GAS, SANITARY SEWER, WATER AND STORMWATER DRAINAGE LINES MAY BE PRESENT AT SOME WORK LOCATIONS. FIELD VERIFICATION IS REQUIRED PRIOR TO ANY CONSTRUCTION. CONTACT PA ONE CALL AND COMPLY WITH ACT 287 (AS AMENDED) REGARDING LOCATIONS OF UNDERGROUND UTILITIES.
- 2. ALL WORK WITHIN THE PUBLIC RIGHT-OF-WAY SHALL BE CONDUCTED IN ACCORDANCE WITH THE REQUIREMENTS OF PENNDOT, THE LOCAL MUNICIPALITY AND THE CONTRACT DOCUMENTS.
- 3. CONTRACTOR SHALL COORDINATE WITH AFFECTED UTILITY COMPANIES IN THE EVENT ITEMS SUCH AS TEMPORARY POLE SUPPORT IS REQUIRED. THIS WORK SHALL BE COMPLETED AT NO ADDITIONAL COST TO THE OWNER.
- 4. EXISTING DRAINAGE FACILITIES SHALL REMAIN INTACT DURING CONSTRUCTION, UNLESS OTHERWISE DIRECTED BY THE ENGINEER.
- 5. ALL AREAS DISTURBED BY THE CONSTRUCTION WORK SHALL BE RESTORED IN ACCORDANCE WITH THE CONTRACT DOCUMENTS TO THEIR ORIGINAL CONDITION OR BETTER.
- 6. ALL DISTURBED AREAS NOT RECEIVING OTHER SURFACE TREATMENT SHALL BE GRADED, SEEDED, AND MULCHED.
- 7. CONTRACTOR SHALL REFER TO CONTRACT DOCUMENTS FOR SOIL EROSION \$ SEDIMENTATION CONTROL PLAN REQUIREMENTS.
- 8. MAINTAIN ACCESS TO DRIVEWAYS AND ENTRANCES LOCATED ALONG THE PROJECT.
- 9. THE CONTRACTOR SHALL ENSURE THAT ALL CONSTRUCTION VEHICLES (INCLUDING MATERIAL SUPPLIER VEHICLES) LEAVING THE PROJECT AREA HAVE MUD BUILDUP REMOVED FROM THE TIRES BEFORE EXITING ONTO PAVED ROADWAYS. ALL MUD TRACKED ONTO PAVED ROADWAYS SHALL BE IMMEDIATELY REMOVED FROM THE ROADWAY.

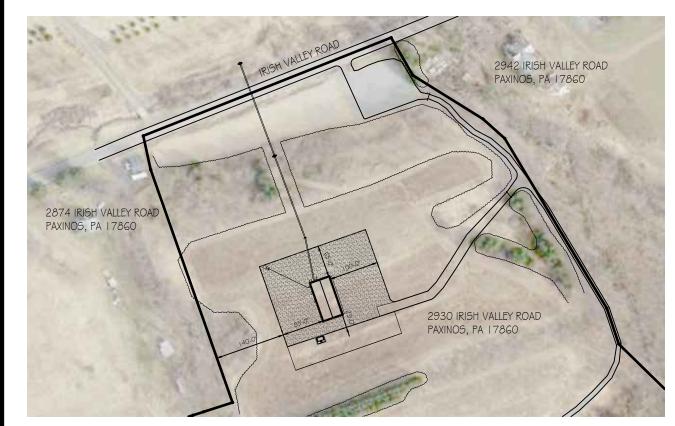


AERIAL LOCATION MAP

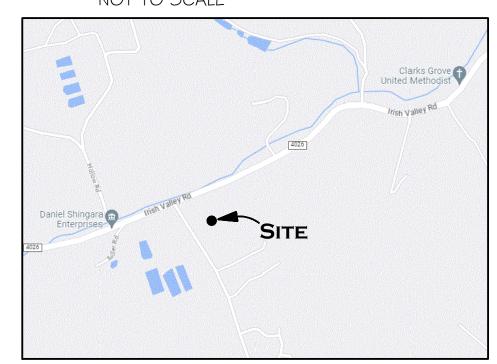

PROJECT VICINITY MAP

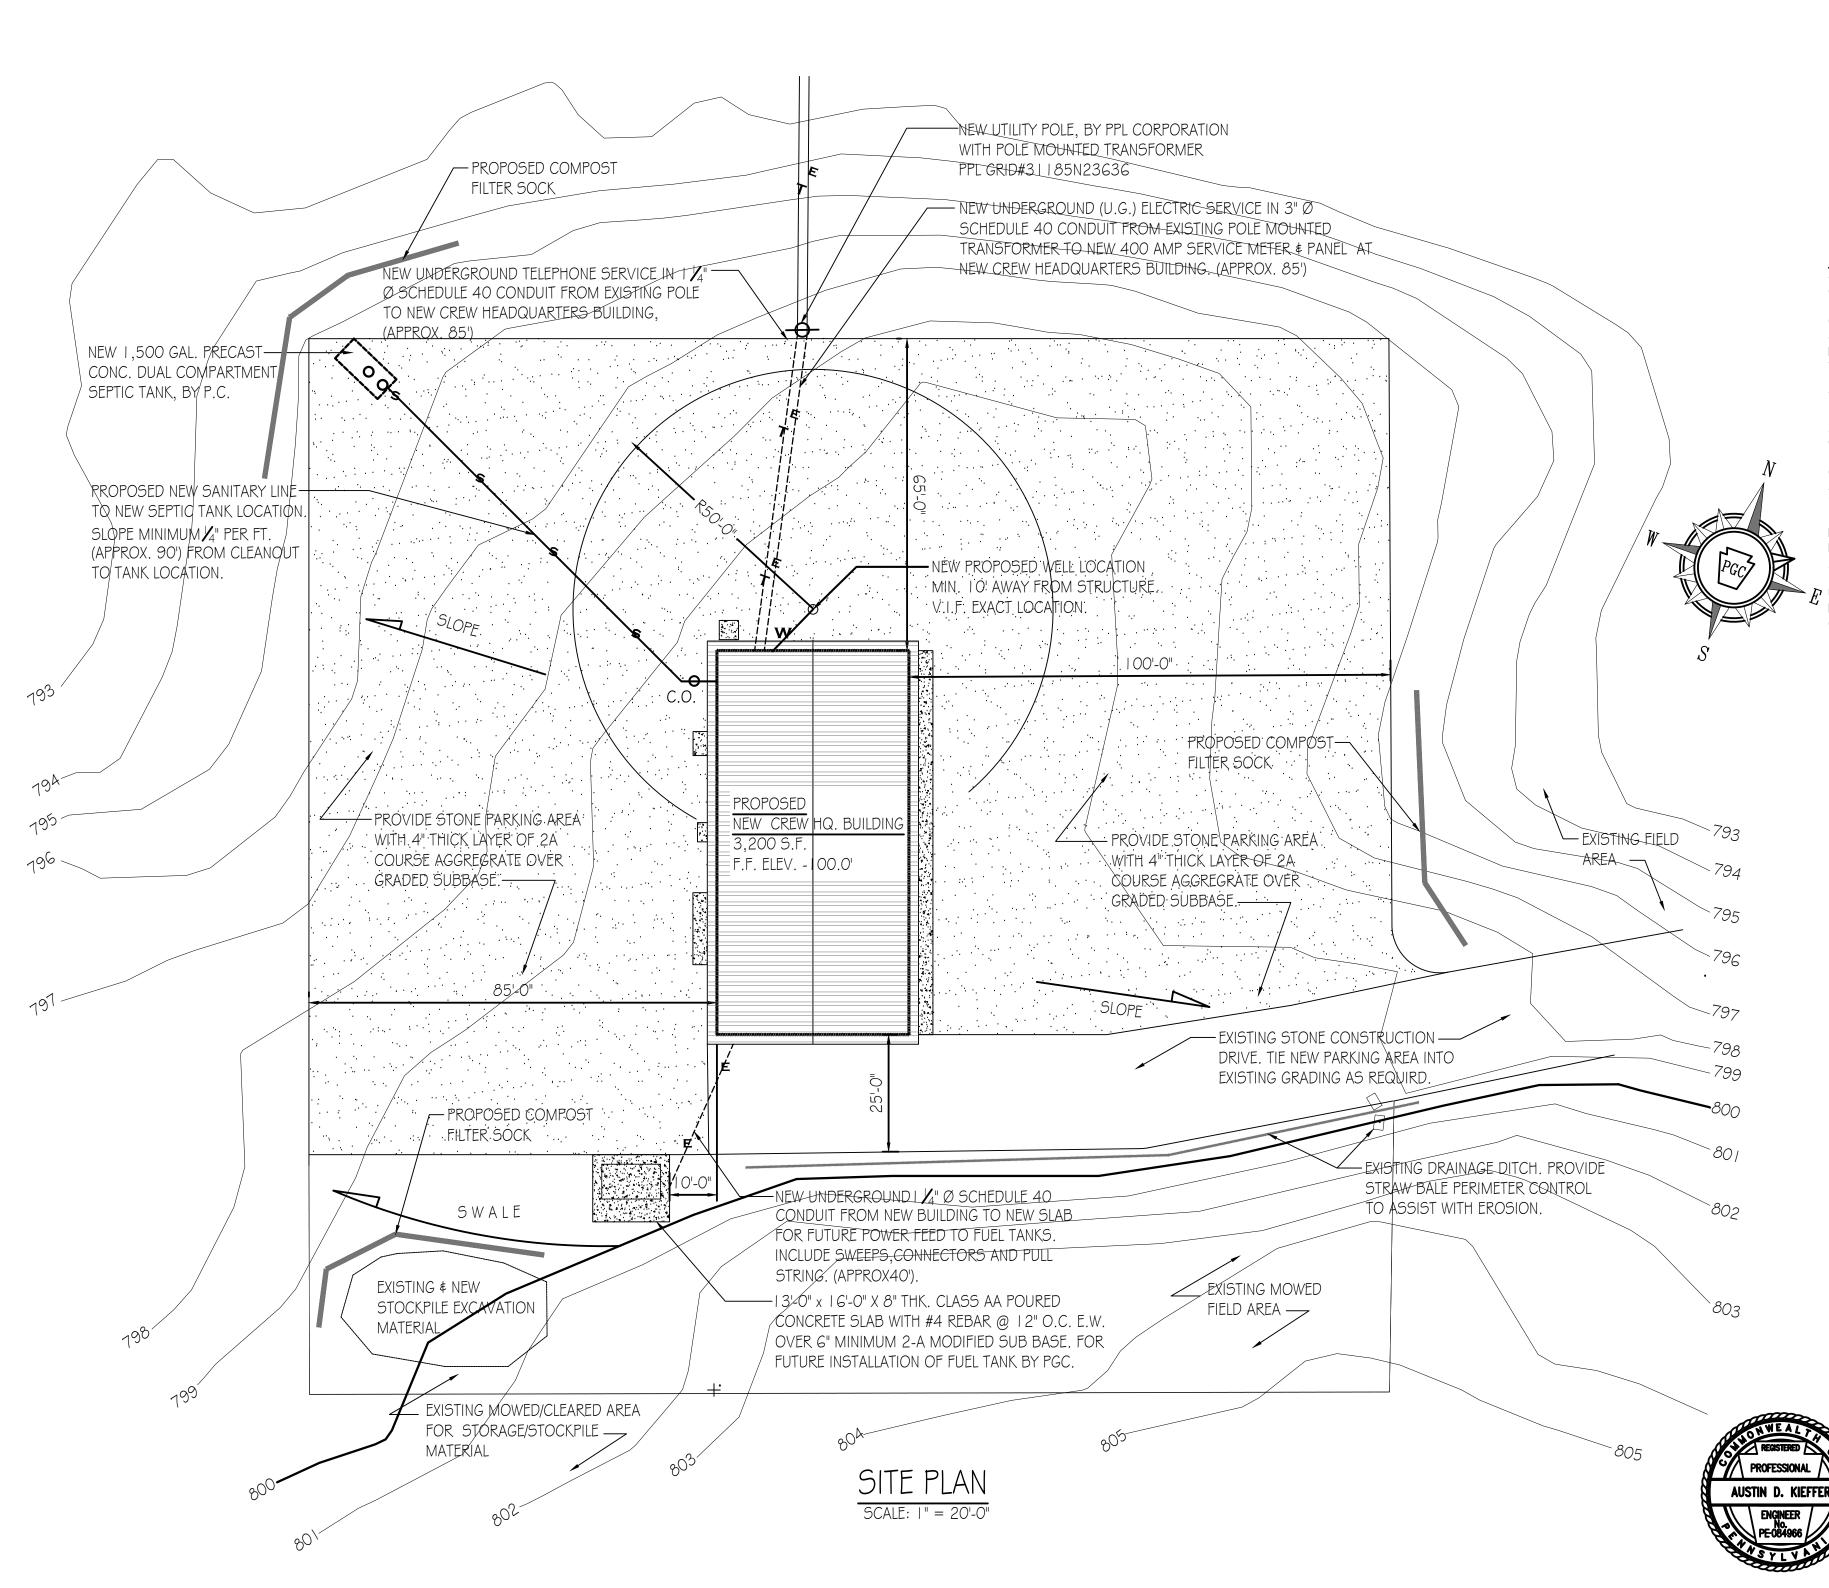

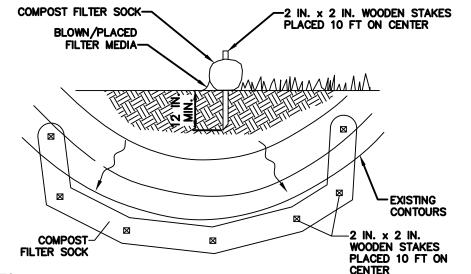

OTES: OCK FABRIC SHALL MEET STANDARDS OF TABLE 4.1 OF THE PA DEP EROSION CONTROL MANUAL.

COMPOST FILTER SOCK SHALL BE PLACED AT EXISTING LEVEL GRADE. BOTH ENDS OF THE BARRIER SHALL BE EXTENDED AT LEAST 8 FEET UP SLOPE AT 45 DEGREES TO THE MAIN BARRIER ALIGNMENT. MAXIMUM SLOPE LENGTH ABOVE ANY BARRIER SHALL NOT EXCEED THAT SPECIFIED FOR THE SIZE OF THE SIZE

TRAFFIC SHALL NOT BE PERMITTED TO CROSS COMPOST FILTER SOCKS

ACCUMULATED SEDIMENT SHALL BE REMOVED WHEN IT REACHES 1/2 THE ABOVE GROUND HEIGH OF THE BARRIER AND DISPOSED IN THE MANNER DESCRIBED ELSEWHERE IN THE PLAN.

COMPOST FILTER SOCKS SHALL BE INSPECTED WEEKLY AND AFTER EACH RUNOFF EVENT. DAMAGE SOCKS SHALL BE REPAIRED ACCORDING TO MANUFACTURER 'S SPECIFICATIONS OR REPLACED WITHIN 24 HOURS OF INSPECTION.

BIODEGRADABLE COMPOST FILTER SOCKS SHALL BE REPLACED AFTER 6 MONTHS; PHOTODEGRADABLE SOCKS AFTER 1 YEAR. POLYPROPYLENE SOCKS SHALL BE REPLACED ACCORDING TO MANUFACTURER'S RECOMMENDATIONS.

P UPON STABILIZATION OF THE AREA TRIBUTARY TO THE SOCK, STAKES SHALL BE REMOVED. THE SOCK MAY BE LEFT IN PLACE AND VEGETATED OR REMOVED. IN THE LATTER CASE, THE MESH SHALL BE CUT OPEN AND THE MULCH SPREAD AS A SOIL SUPPLEMENT.

STANDARD CONSTRUCTION DETAIL #4-1
COMPOST FILTER SOCK

#### ALL EXCESS FILL MATERIAL TO BE STORED AND/OR DISPOSED OF SHALL BE OUTSIDE OF THE 50'

FLOODPLAIN, AT AN UPLAND LOCATION ON EXISTING ROADWAY.

SILT SOCK SHALL BE PLACED AROUND ALL STOCKPILED MATERIALS.

THE PGC WILL STABILIZE ALL DISTURBED AREAS IMMEDIATELY AFTER ALL EARTH DISTURBANCE ACTIVITIES CEASE. DURING NON-GERMINATION PERIODS, MULCH MUST BE APPLIED AT A RATE OF 1.2 LBS./SY.

IMMEDIATELY UPON DISCOVERING UNFORESEEN CIRCUMSTANCES POSING THE POTENTIAL TO ACCELERATE EROSION/SEDIMENTATION, THE PGC SHALL IMPLEMENT ADDITIONAL APPROPRIATE BMPS TO MITIGATE THE PROBLEM.

THE PGC SHALL NOTIFY DEP OF ANY REVISION TO THIS PLAN FOR REVIEW AND APPROVAL PRIOR TO INITIATING ANY CHANGES.

ALL CONSTRUCTION WASTE WILL BE REMOVED FROM THE SITE AND DISPOSED OF IN ACCORDANCE WITH ALI DEP SOLID WASTE MANAGEMENT REGULATIONS; 25 PA CODE 260.1 ET SEQ. 271.1 ET SEQ. NO WASTE SHALL BE BURIED, BURNED, OR DUMPED AT THE SITE.

ALL SEDIMENT COLLECTED FROM BMPS SHALL BE RESTORED TO UPLAND AREAS AND STABILIZED.

BMPS SHALL NOT BE REMOVED UNTIL 70% VEGETATIVE COVER IS ESTABLISHED ACROSS THE ENTIRE PROJECT AREA. EXPOSED ROAD SURFACE SHALL BE COVERED WITH A 4-INCH LAYER OF COMPACTED #2A COARSE AGGREGATE.

PERMANENT STABILIZATION IS DEFINED AS A MINIMUM UNIFORM 70% PERENNIAL COVER OR OTHER MEANS WITH A DENSITY CAPABLE OF RESISTING ACCELERATED EROSION AND SEDIMENTATION.

ALL BMPS SHALL REMAIN IN PLACE UNTIL THE SITE IS STABILIZED. MAINTENANCE OF BMPS INCLUDES WEEKLY INSPECTIONS AND AFTER EACH RAINFALL EVENT. IF A BMP FAILS TO PERFORM AS EXPECTED, REPLACEMENT AND MEDICATION MAY BE NECESSARY.

### DRAWING INDEX

CS-I COVER SHEET & BUILDING SITE PLAN

A-I BUILDING FLOOR PLAN & ELEVATIONS

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P-1 PLUMBING FLOOR PLAN. ELEVATIONS \$ DETAILS

M-I MECHANICAL FLOOR PLAN & DETAILS

E- I ELECTRICAL FLOOR PLAN, SCHEDULES & DETAILS

	PENNSYLVANIA GAME COMMISSION					
	SGL # 165	SHAMOKIN TOWNSHIP	NORTHUMBERLAND COUNTY			
	NEW 40'x80' CREW HEADQUARTERS BUILDING COVER SHEET & BUILDING SITE PLAN					


REVISIONS


PROJECT NO. PGC-165-23-01


DRAWN BY: M. SPOTTS

DATE: 10/16/2023

SHEET NO. CS-1

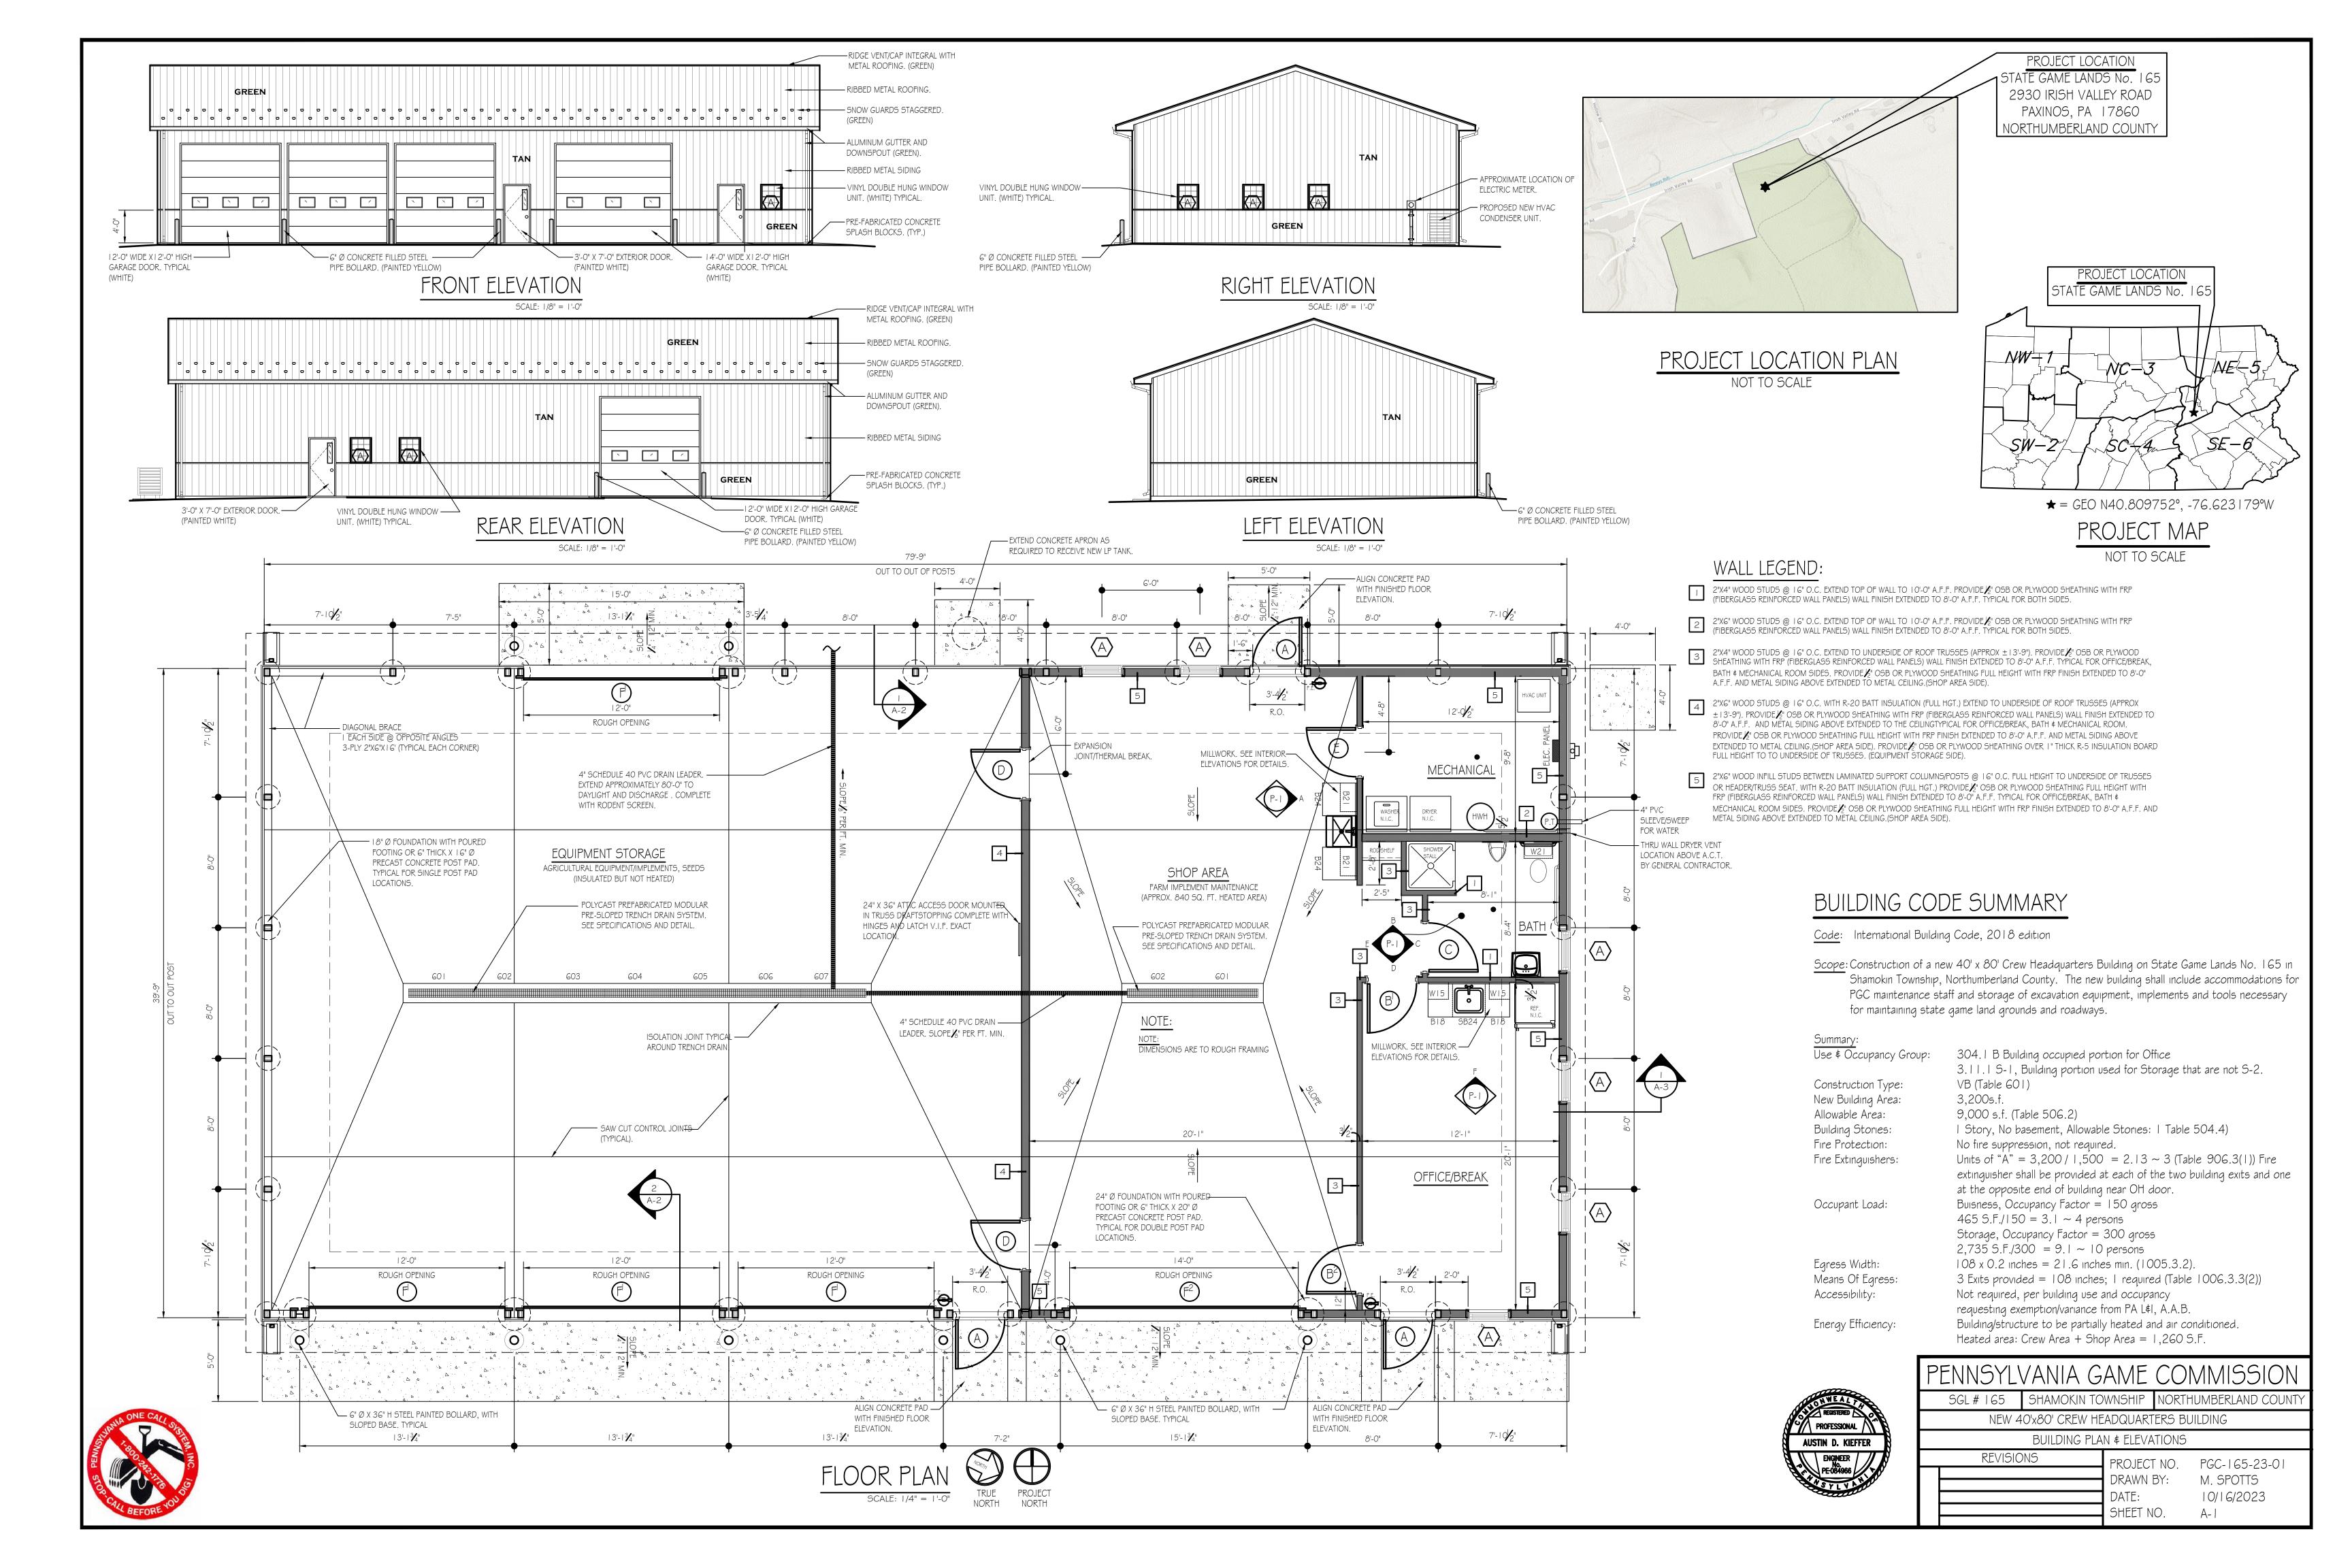


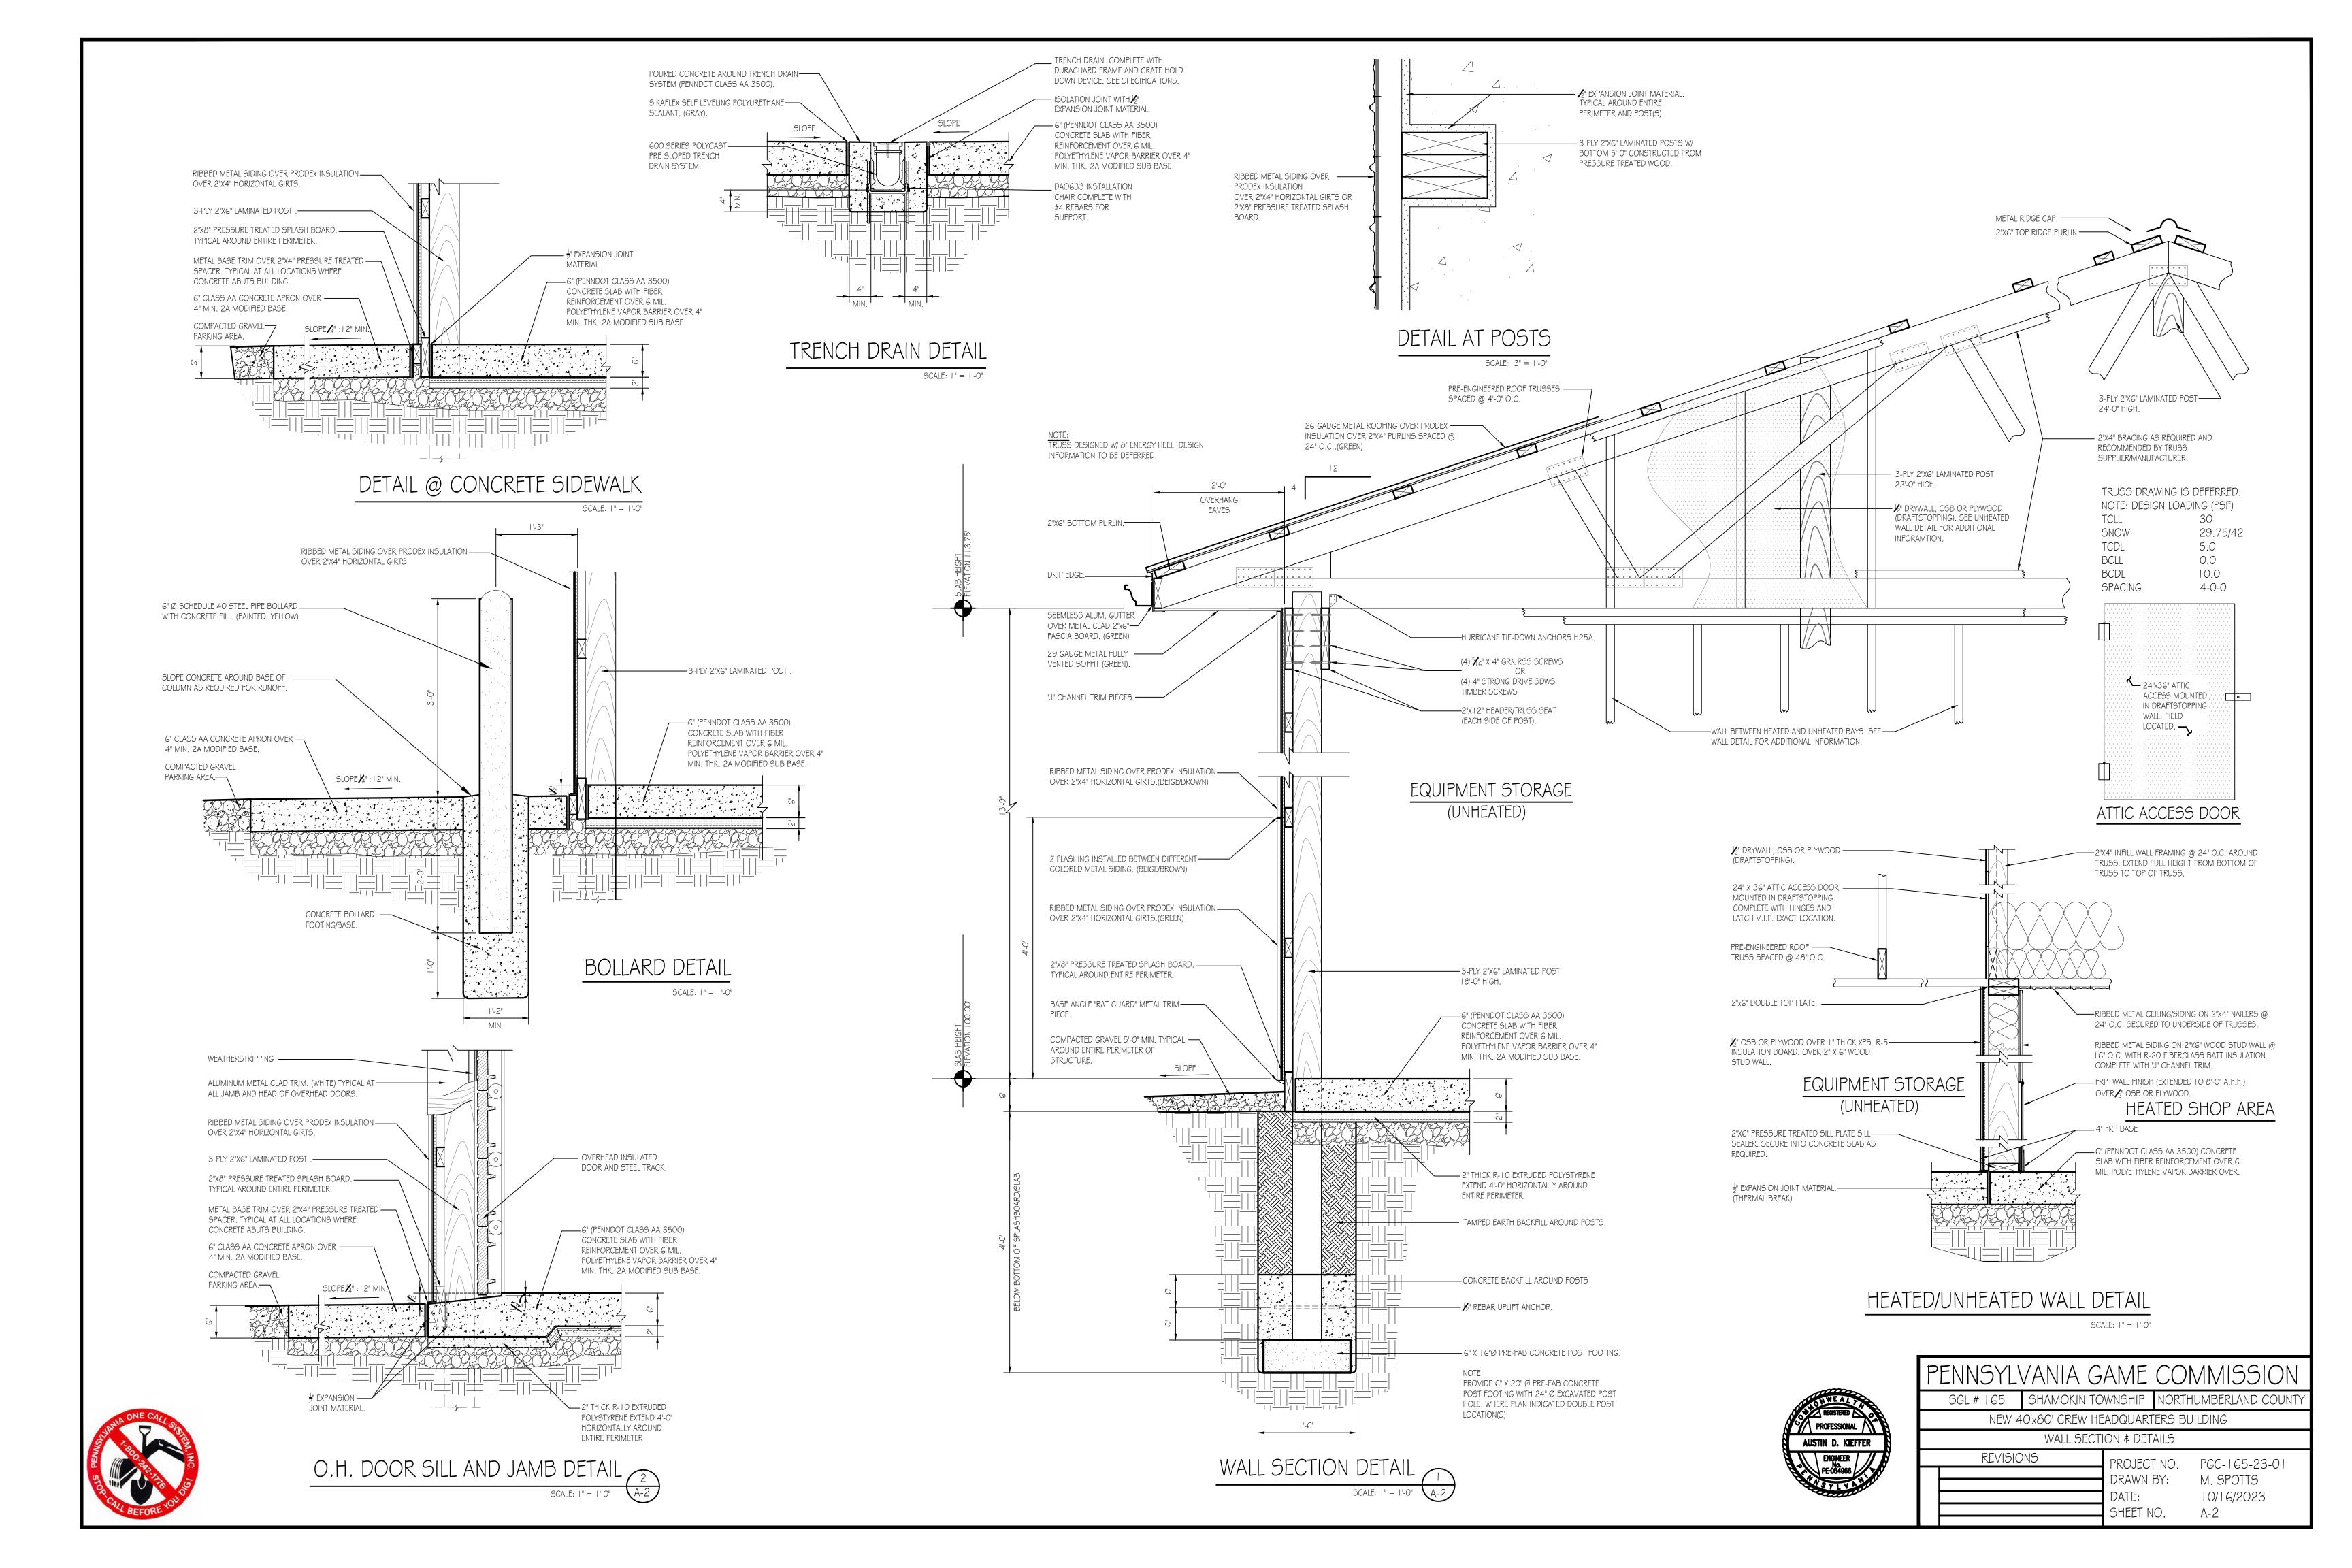

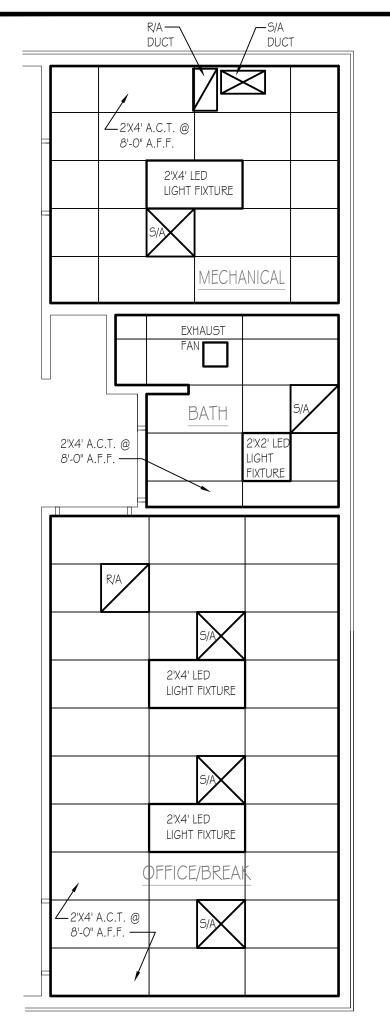

# REFLECTED CEILING PLAN

MA	\RK	TYPE	MANUFACTURER	ROUGH OPENING	COLOR	QTY.	REMARKS
	Α	-	VINYL	2'-6" x 3'-0"	WHITE	6	WINDOW UNIT IN BATH TO HAVE BOTTOM SASH TEMPERED GLASS

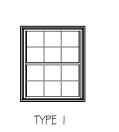


#### WINDOW SCHEDULE NOTES:

I)ALL WINDOWS TO BE COMPLETE WITH CLEAR LOW E GLASS W/ ARGON, INSECT SCREENS, GRILLES BETWEEN GLASS, INTEGRAL "J" CHANNEL TRIM AND TEMPERED GLASS AS REQUIRED BY CODE.

2)EXTERIOR AND INTERIOR WINDOW COLOR TO BE WHITE. 3)SEE SPECIFICATIONS FOR ADDITIONAL WINDOW INFORMATION.

# WINDOW SCHEDULE

MARK	TYPE	WIDTH	HGT.	THK.	HAND	QTY.	REMARKS
А	3	3'-0"	7'-0"	I -3/4"	LHR	3	INSULATED CORE W/ GLASS, PANIC EXIT DEVICE, CLOSER
B <sup>l</sup>	I	3'-0"	7'-0"	I -3/4"	RH	I	NON-INSULATED W/GLASS # PASSAGE SET
B <sup>2</sup>	1	3'-0"	7'-0"	I -3/4"	RHR	- 1	NON-INSULATED W/GLASS \$ PASSAGE SET
С	2	3'-0"	7'-0"	I -3/4"	RH	-	NON-INSULATED W/ PRIVACY SET
D	1	3'-0"	7'-0"	I -3/4"	LHR	2	INSULATED CORE W/ GLASS, PANIC EXIT DEVICE, CLOSER
E	4	3'-0"	7'-0"	I -3/4"	LHR	1	NON-INSULATED W/GLASS, VENT \$ PASSAGE SET
F	О.Н.	12'-0"	12'-0"	SEE SPECIFIC	CATIONS	4	INSULATED SECTIONAL OVERHEAD DOOR
F <sup>2</sup>	О.Н.	14'-0"	12'-0"	SEE SPECIFIC	CATIONS	1	INSULATED SECTIONAL OVERHEAD DOOR

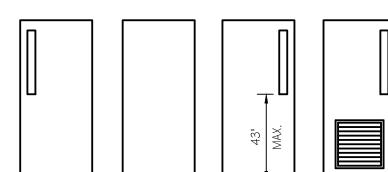

TYPE 2


TYPE I

#### DOOR SCHEDULE NOTES:


I) ALL CORES TO BE BEST CORMAX, 7 PIN COMPATIBLE. 2) SEE PROJECT SPECIFICATIONS FOR DOOR FRAMES \$ DOOR HARDWARE REQUIRED.

DOOR SCHEDULE


TYPE 4

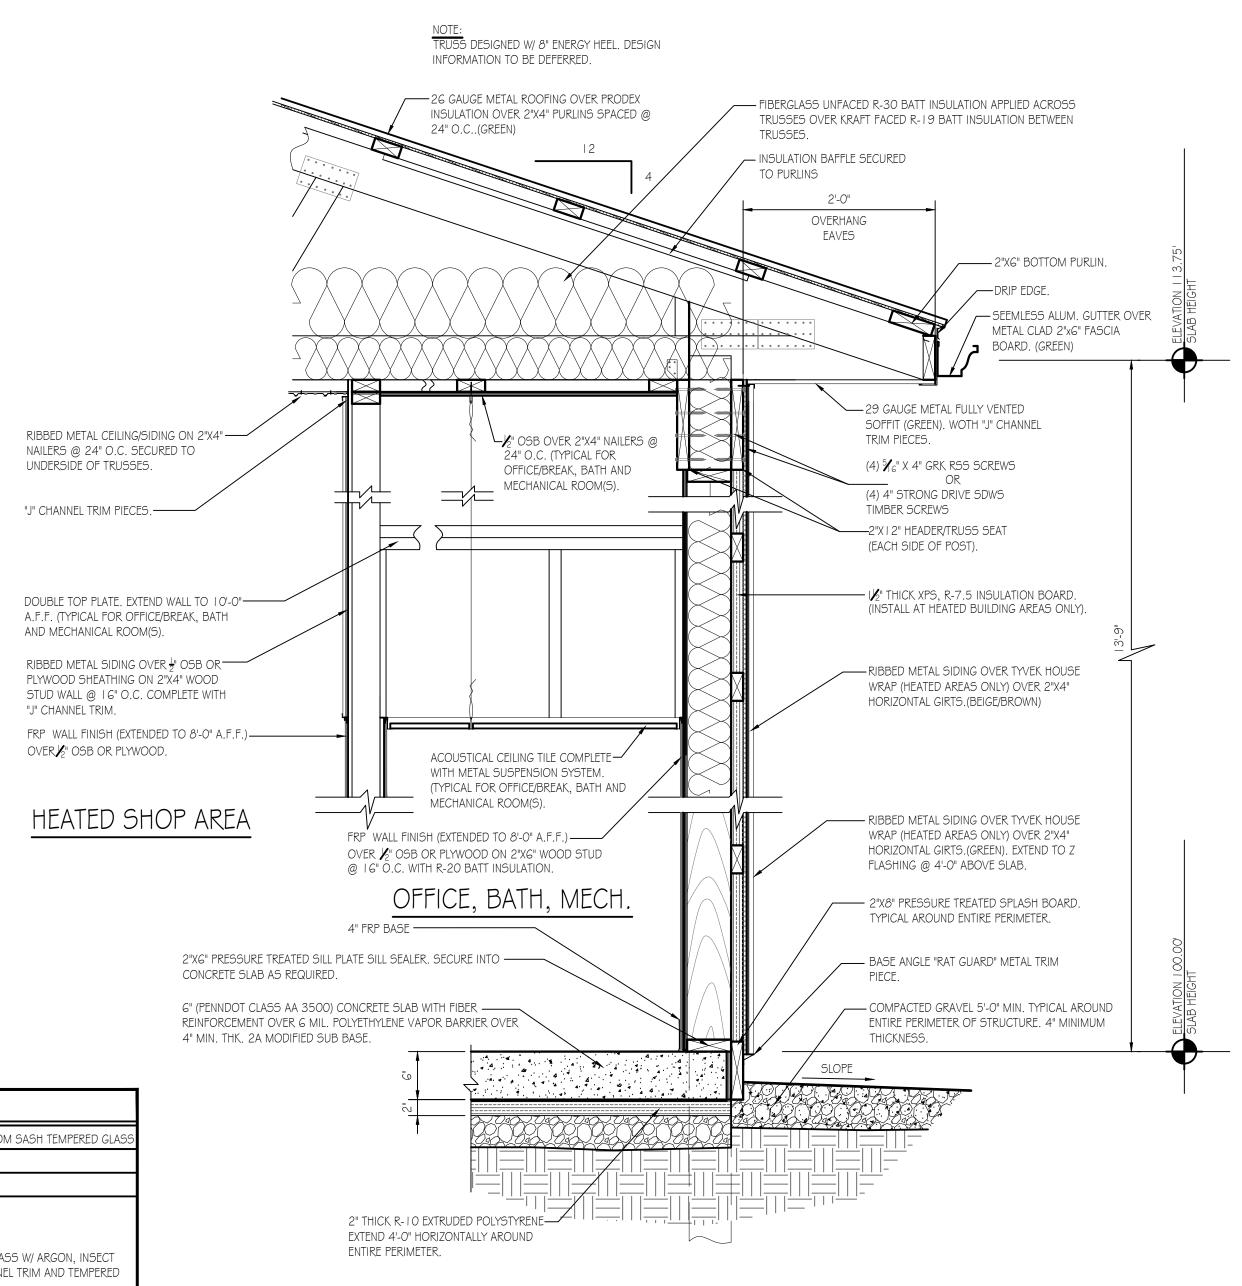




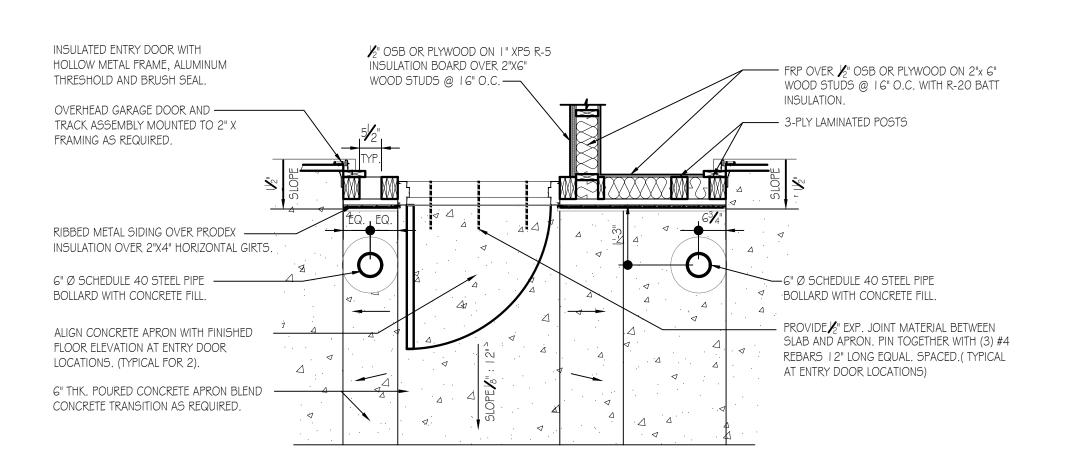


DETAIL AT ENTRY DOOR

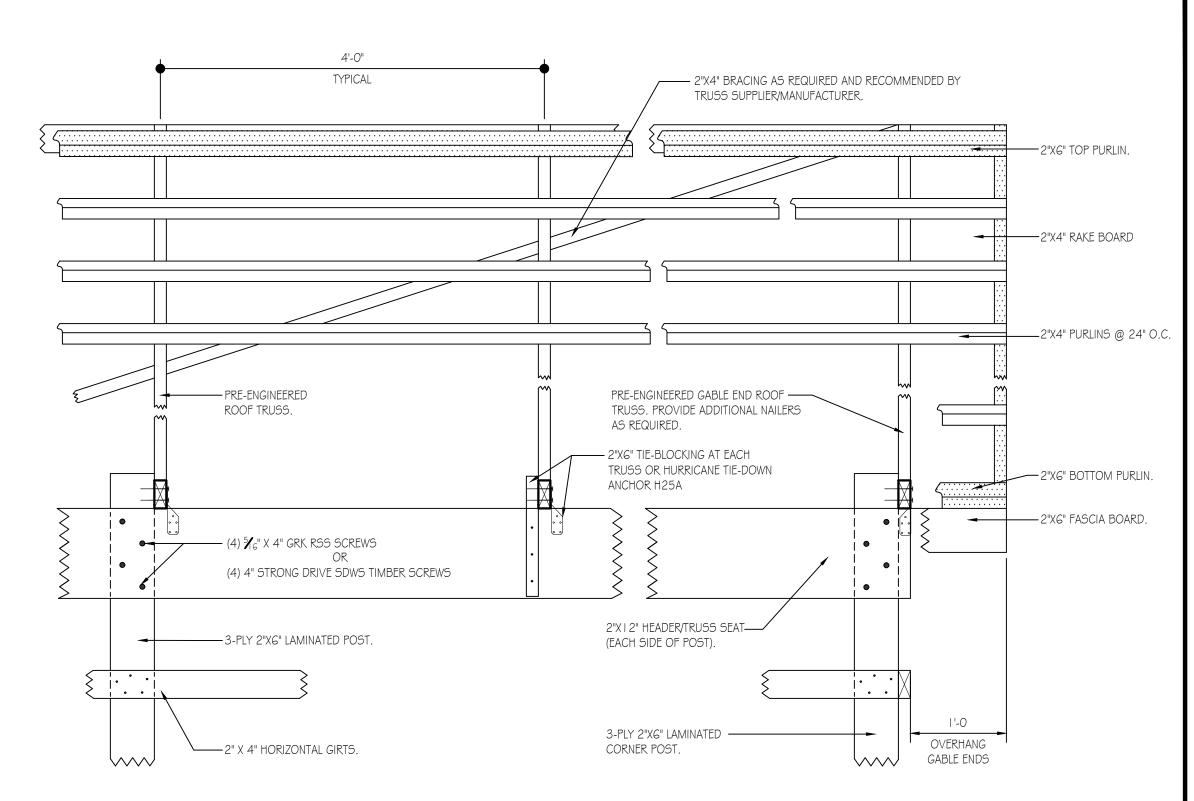

### TYPICAL ROOF FRAMING/BRACING DETAIL

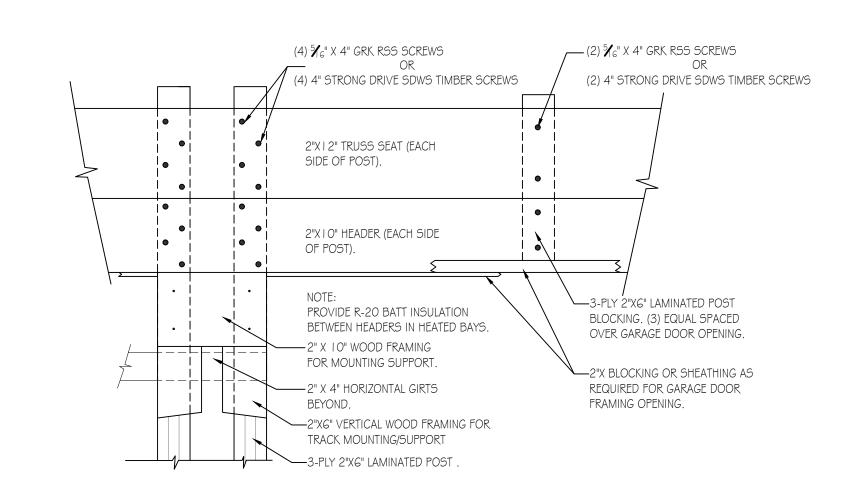

### GARAGE DOOR FRAMING DETAIL

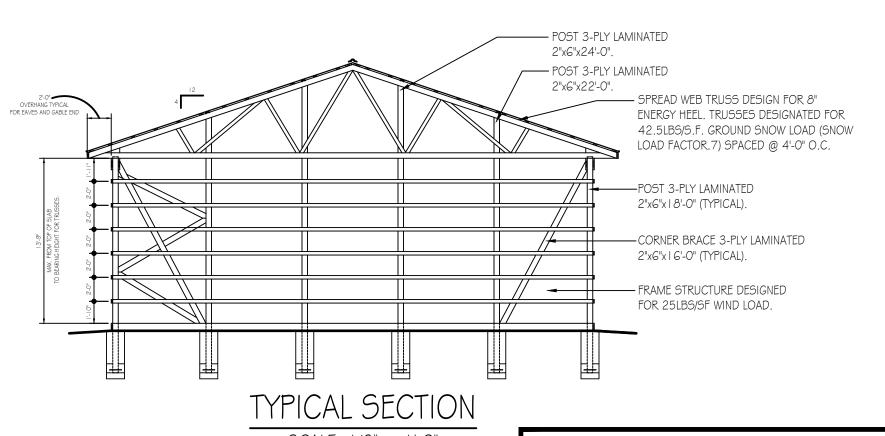

SCALE: 1/8" = 1'-0"




PENNSYLY	VANIA GAME	COMMISSION
SGL # 165	SHAMOKIN TOWNSHIP	NORTHUMBERLAND COUNTY


NEW 4	O'x80' CREW HEADQUART	ERS BUILDING
SECTIONS, D	ETAILS,SCHEDULES & REF	LECTED CEILING PLAN

DETAILS, SCHLDO	LLJ 4 KLI LLCTLD	CLILING I LAN
IONS	PROJECT NO.	PGC-165-23-01
	DRAWN BY:	M. SPOTTS
	DATF.	10/16/2023

SHEET NO.



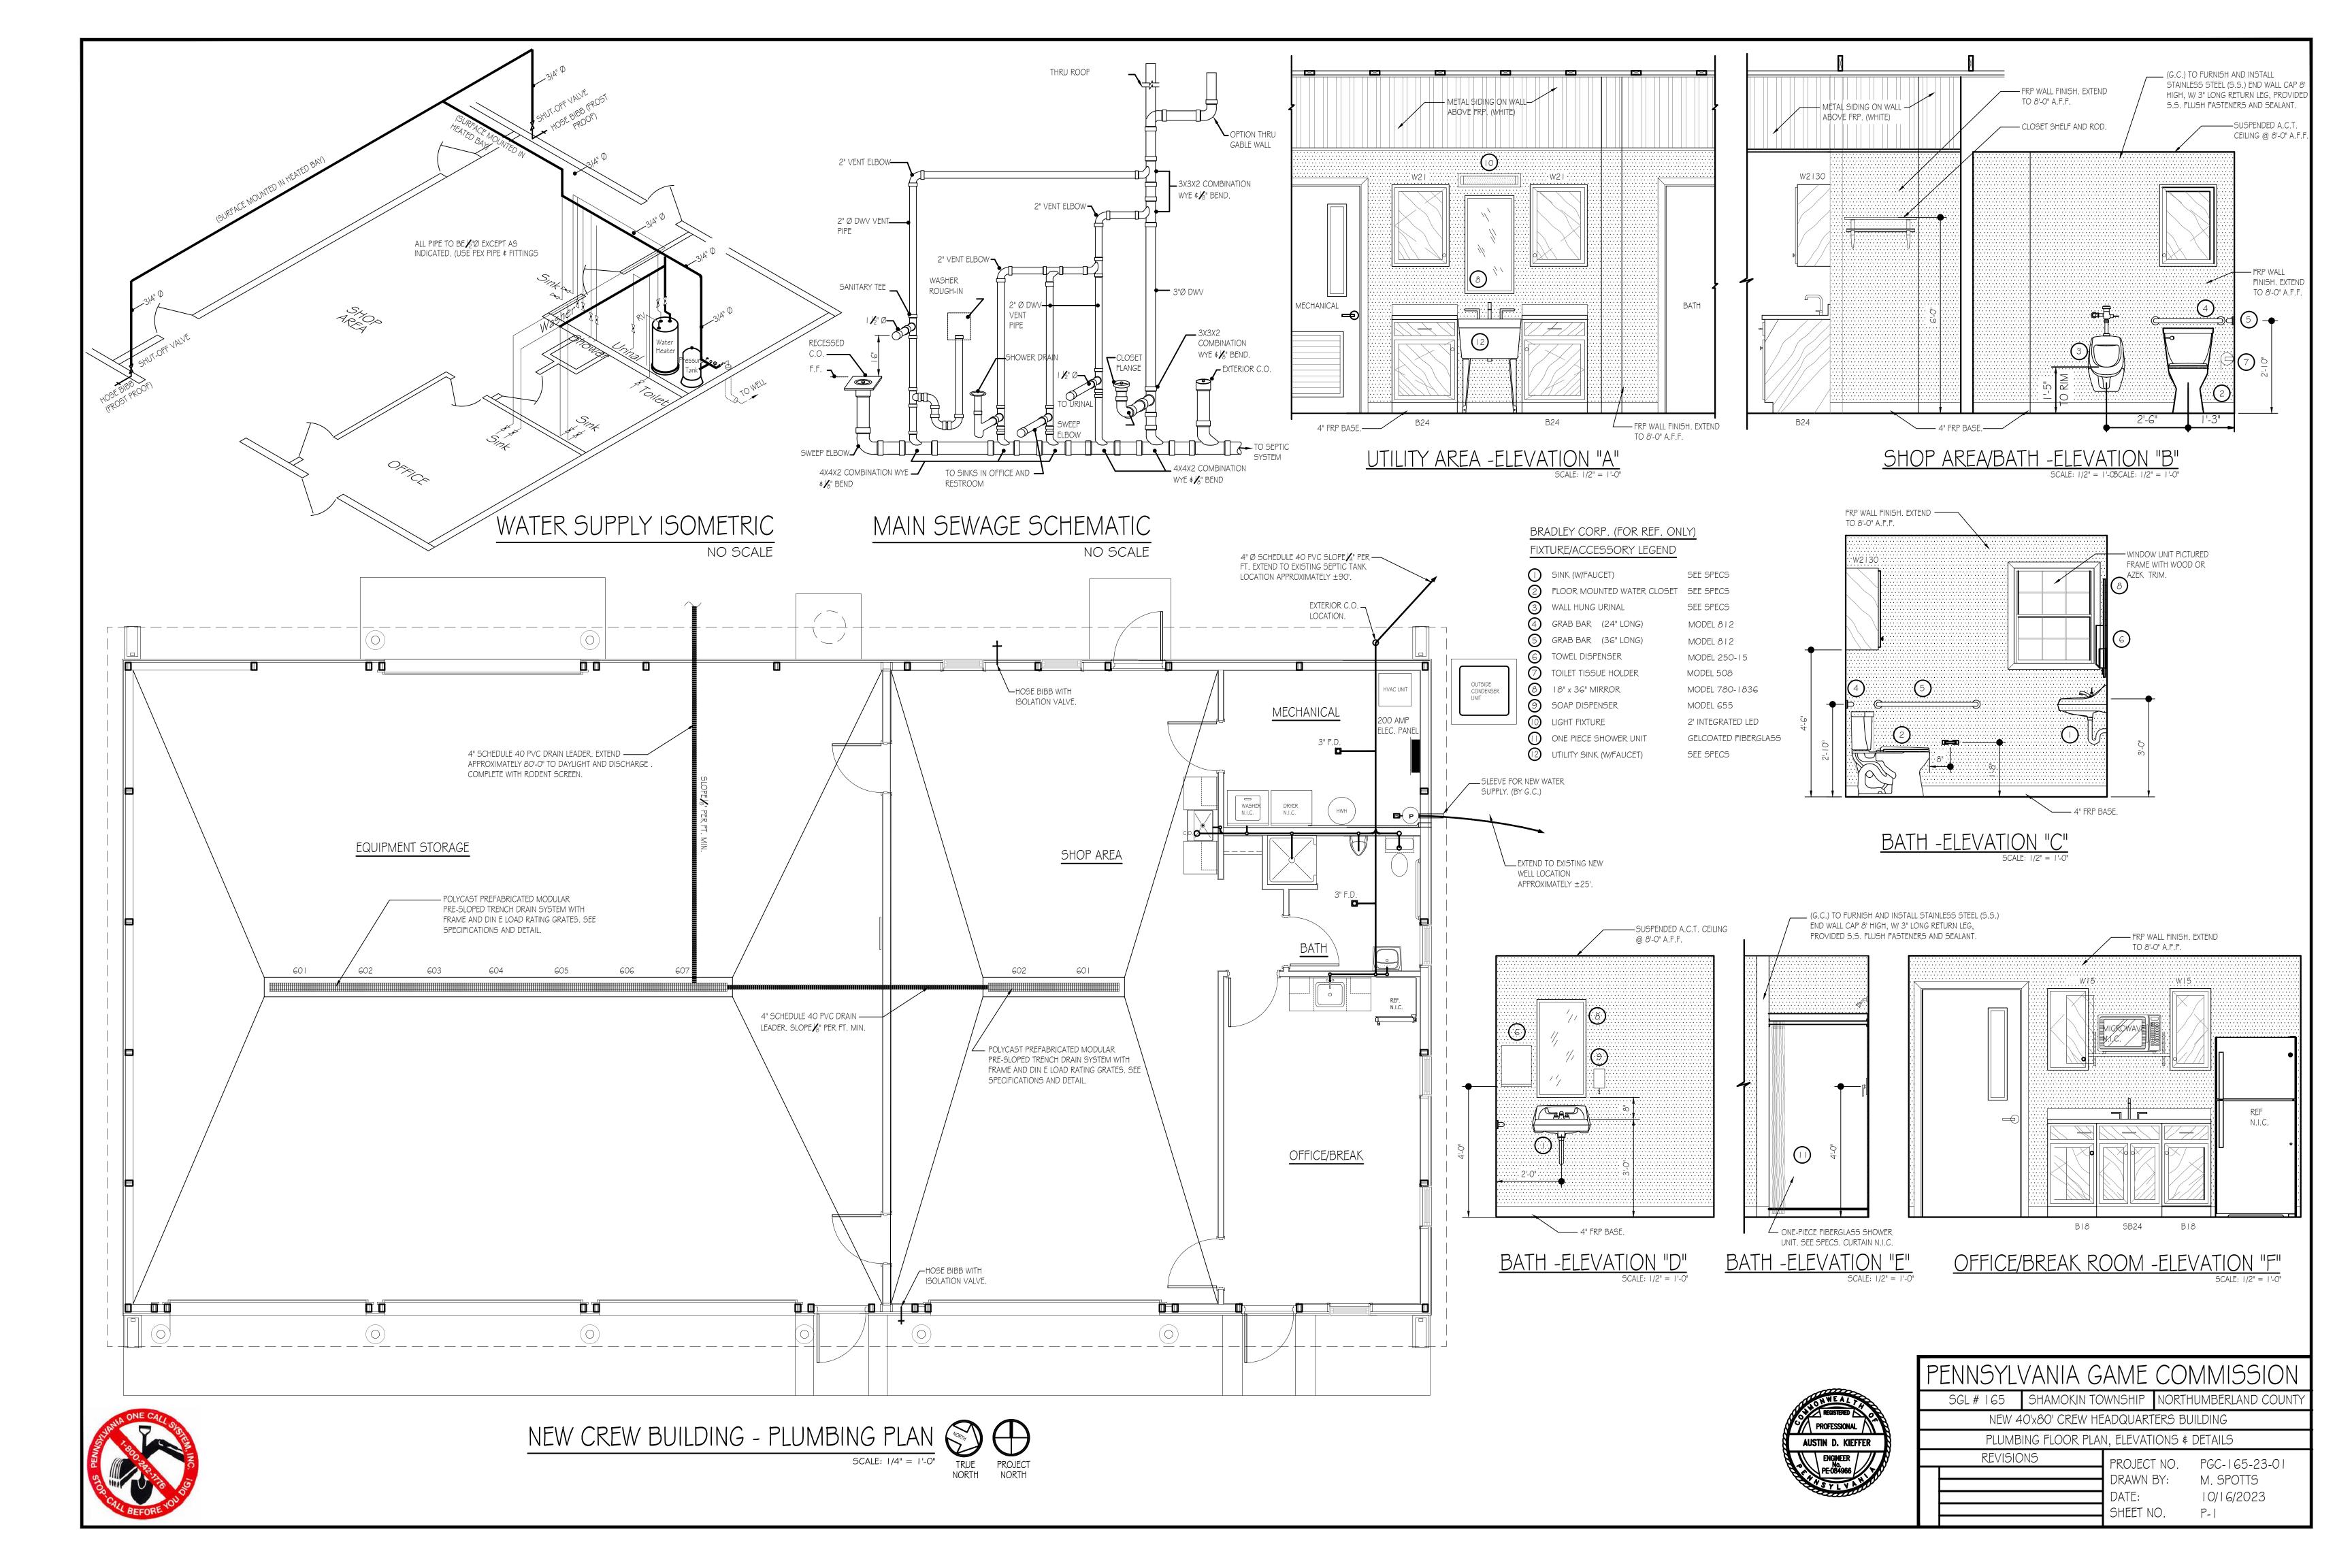

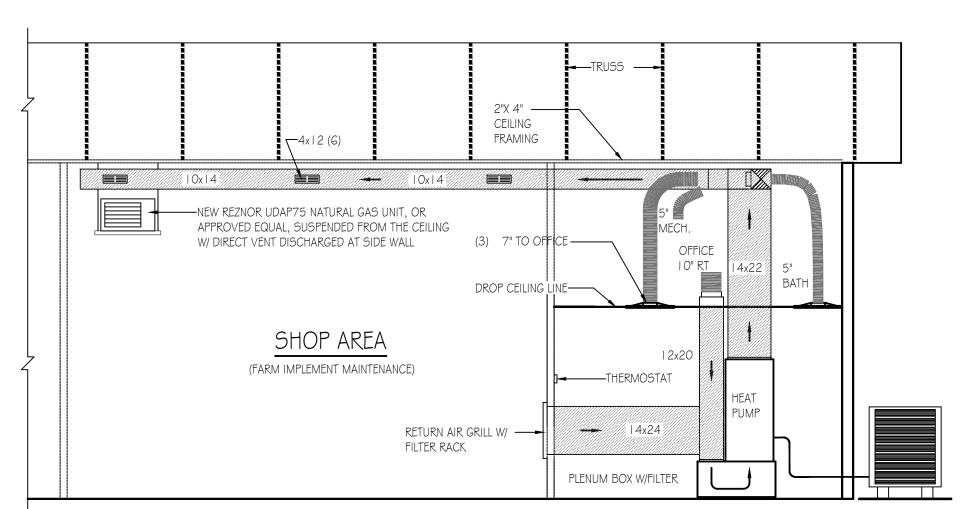

#### MECHANICAL CONSTRUCTION NOTES:

HVAC SYSTEM TO BE A BOSCH HEAT PUMP SYSTEM. LAYOUT OF DUCTS, DUCT SIZES AND DIFFUSERS ARE MEANT TO BE USED AS A GUIDELINE. ACTUAL RUNS, SIZES AND LOCATIONS TO BE DETERMINED BY MANUFACTURER'S MODEL.

THE FOLLOWING STEPS SHOULD BE FOLLOWED IN THE DESIGN AND INSTALLATION OF THE HVAC SYSTEM TO ENSURE EFFICIENCY AND COMFORT.

I. DETERMINE ROOM-BY-ROOM AND AIR-FLOWS USING ACCA MANUAL J CALCULATION PROCEDURES. (OR SUBSTANTIALLY EQUIVALENT)

3. SIZE HVAC EQUIPMENT TO SENSIBLE LOAD USING ACCA MANUAL S CALCULATION PROCEDURES (OR SUBSTANTIALLY EQUIVALENT). 4. INSTALL EQUIPMENT \$ DUCTS ACCORDING TO DESIGN SPECIFICATIONS USING INSTALLATION PROCEDURES FROM SMACNA / MANUFACTURERS' SPECS.

5. INSTALL SO STATIC AIR PRESSURE DROP ACROSS THE AIR HANDLER IS WITHIN MANUFACTURER AND DESIGN SPECIFICATIONS. 6. PROVIDE BALANCED AIR FLOWS BETWEEN SUPPLY AND RETURN SYSTEMS TO MAINTAIN NEUTRAL PRESSURE.


2. SIZE DUCT SYSTEM ACCORDING TO ACCA MANUAL D CALCULATION PROCEDURES. (OR SUBSTANTIALLY EQUIVALENT)

7. EQUIPMENT AND ASSOCIATED ITEMS MUST BE APPROVED BY PGC HARRISBURG ENGINEERING DIVISION BEFORE START OF INSTALLATION.

HEAT PUMP TO BE A 5 TON BOSCH BOVA - 060-HDN I - M I 8M OUTSIDE CONDENSER UNIT W/ BGH96M I 00C5B AIR HANDLER/FURNACE AND BMAC48GOCNTF CASE COIL. UNITS TO ACHIEVE A MINIMUM 17 SEER AND 9.5 HSPF (OR SUBSTANTIALLY EQUIVALENT). SEE SPECIFICATIONS.

BUILDING SECTION - MECHANICAL

SCALE: 1/4" = 1'-0"

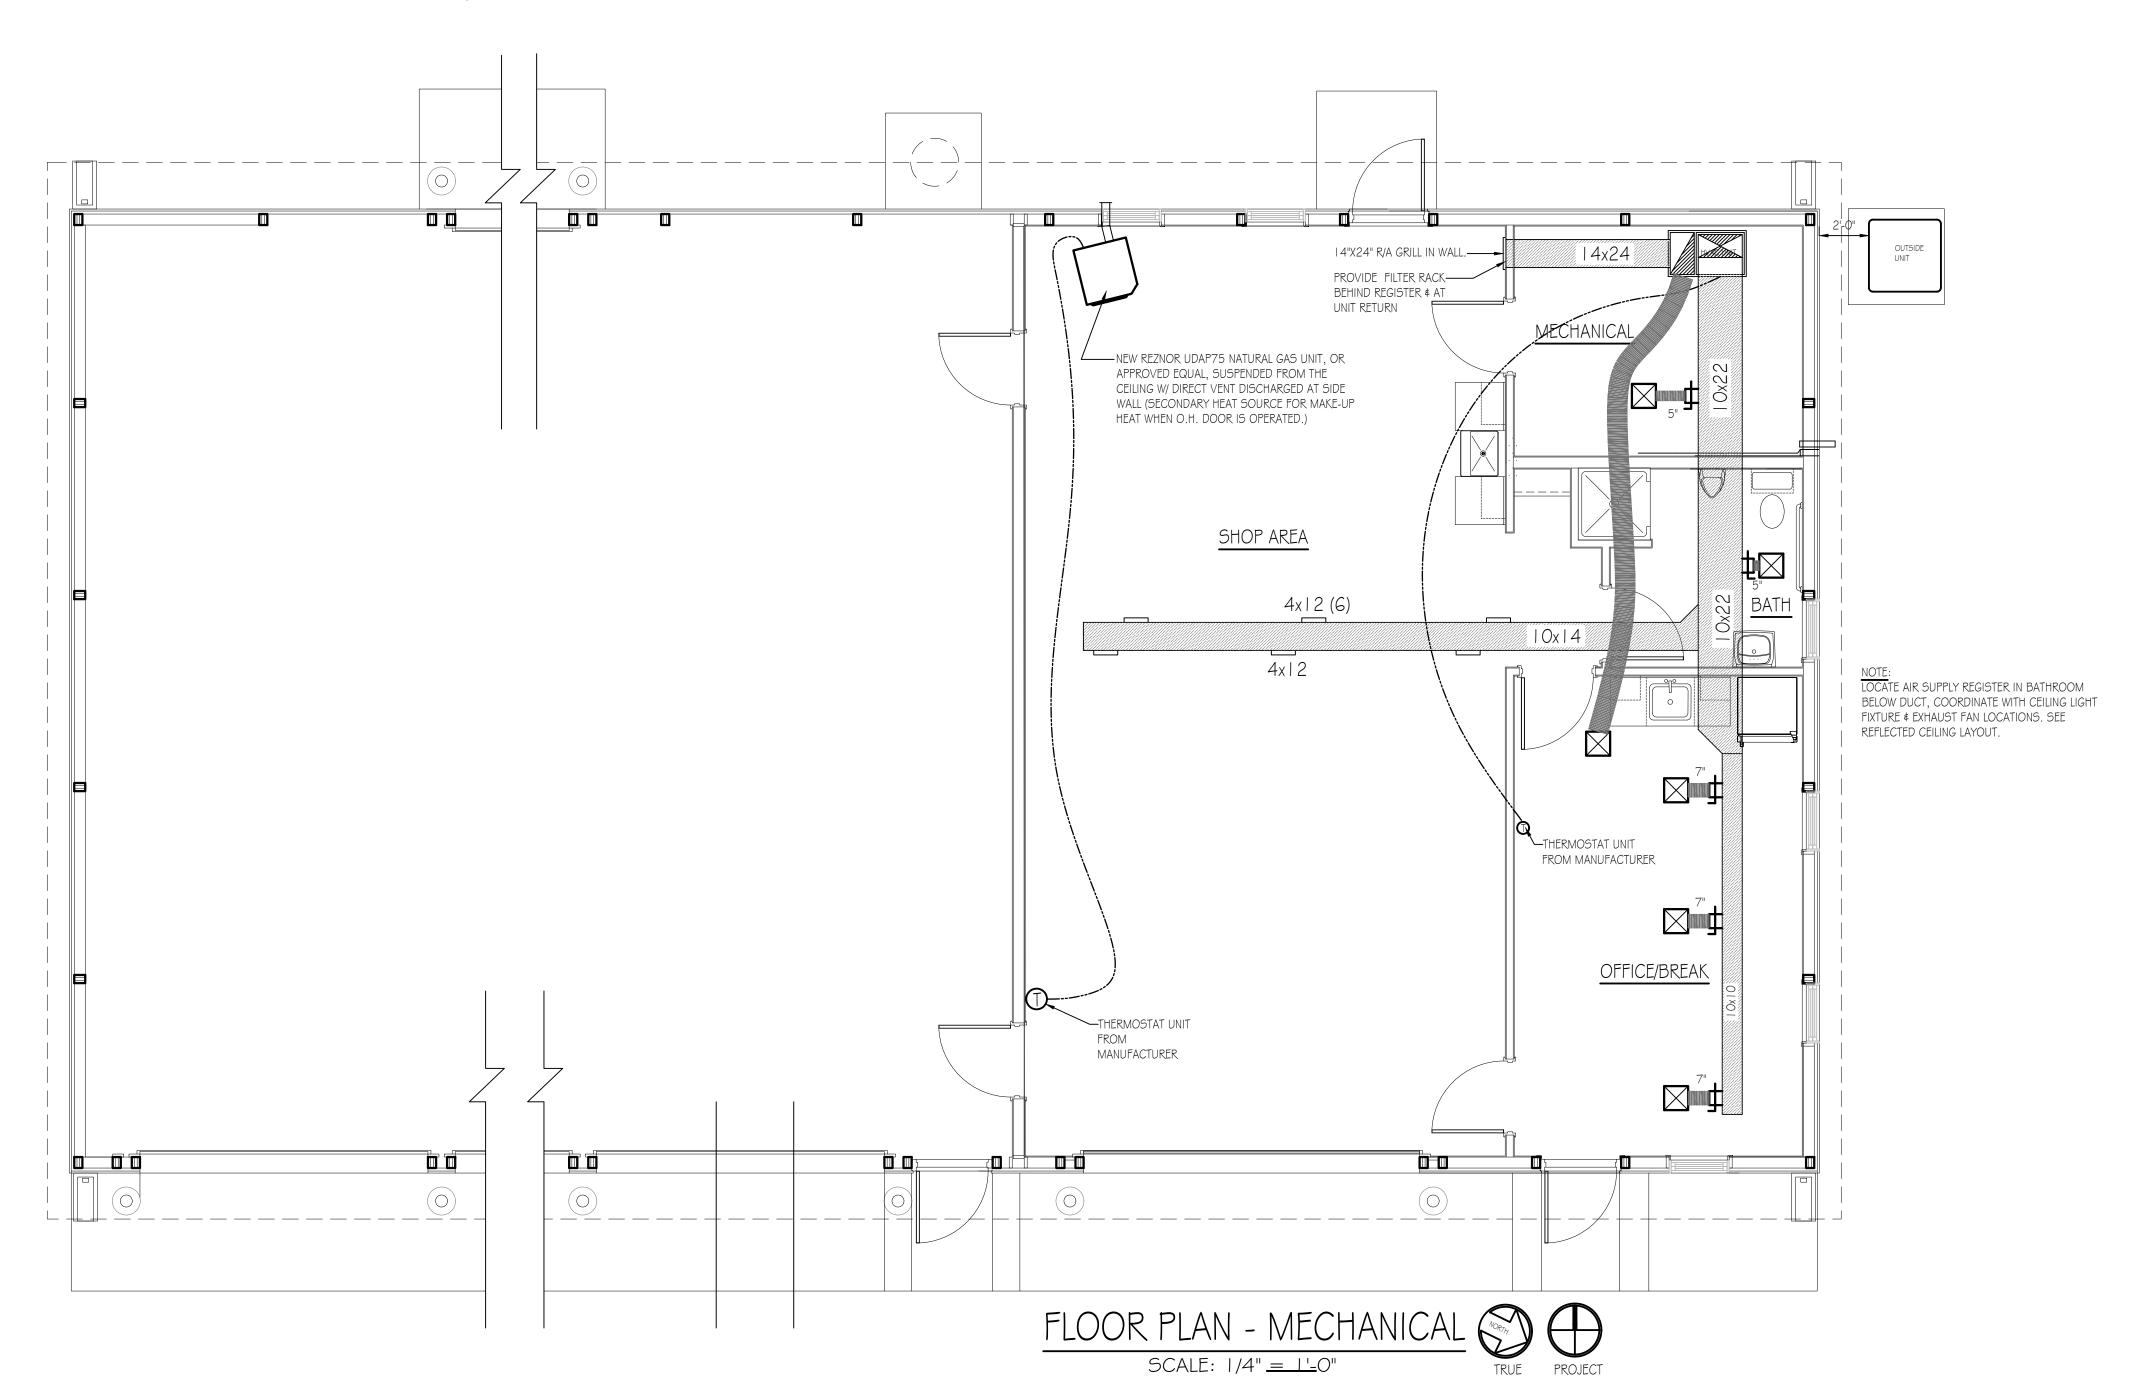



PENNSYL	VANIA GAME	COMMISSION		
SGL # 165	SHAMOKIN TOWNSHIP	NORTHUMBERLAND COUNTY		
NEW 40'x80' CREW HEADQUARTERS BUILDING				

MECHANICAL FLOOR PLAN AND DETAILS REVISIONS

PROJECT NO. PGC-165-23-01 M. SPOTTS DRAWN BY:

SHEET NO.

10/16/2023



